


# EAST ELEVATION ERF 29181 **SCALE 1:100**



# WEST ELEVATION ERF 29181 **SCALE 1:100**

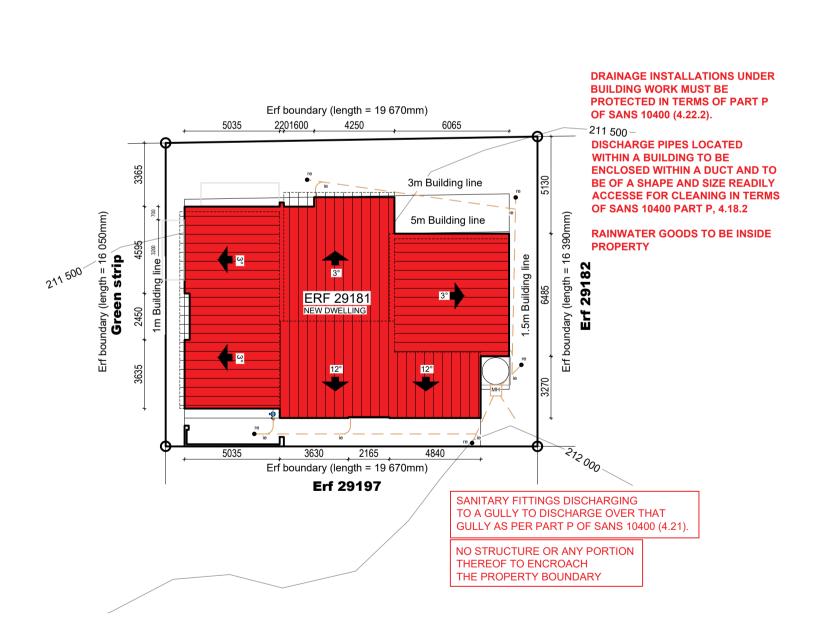

SITE PLAN **SCALE 1:200** 

**NOTES:** 

**GROUND FLOOR PLAN** 

U/S OF LINTEL

U/S OF LINTEL

## **ELECTRICAL LIGHTS & GAS** LAYOUT PLAN FOR GAS **DETAIL. SAFETY DISTANCES** AND REGULATIONS

# **NB: PLEASE CONSULT DRAINAGE & REFERENCE** PLANS AND ELEVATIONS FOR RAINAGE HEIGHTS, LEVELS

## THEREOF TO ENCROACH THE Site boundary line 15x150mm -Plaster band 1,8m High brick boundary wall to indicated dimensions. (Gem-blocks) — Bagged finish & 250x550mm Concrete foundation.

NO STRUCTURE OR ANY PORTION

PROPERTY BOUNDARY

PERGOLA TO

painted brick

3.6 W

WC

REMAIN OPEN AS

PER BUILDING PLAN


New 110mm dia uPVC sewer pipe, minimum fall 1:40

building and driveways to be cast in concrete as per


ENG specification)

210 940 and 450mm under n.g.l. (All sewer pipes under the

# NORTH ELEVATION 29181 **SCALE 1:100**

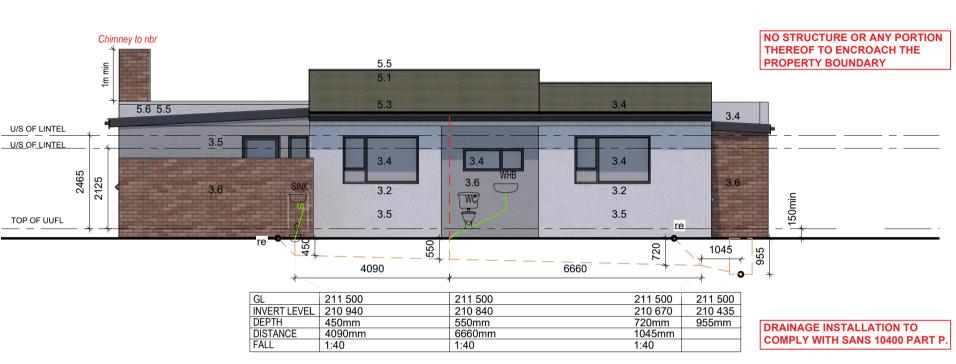

# **SOUTH ELEVATION 29181 SCALE 1:100**

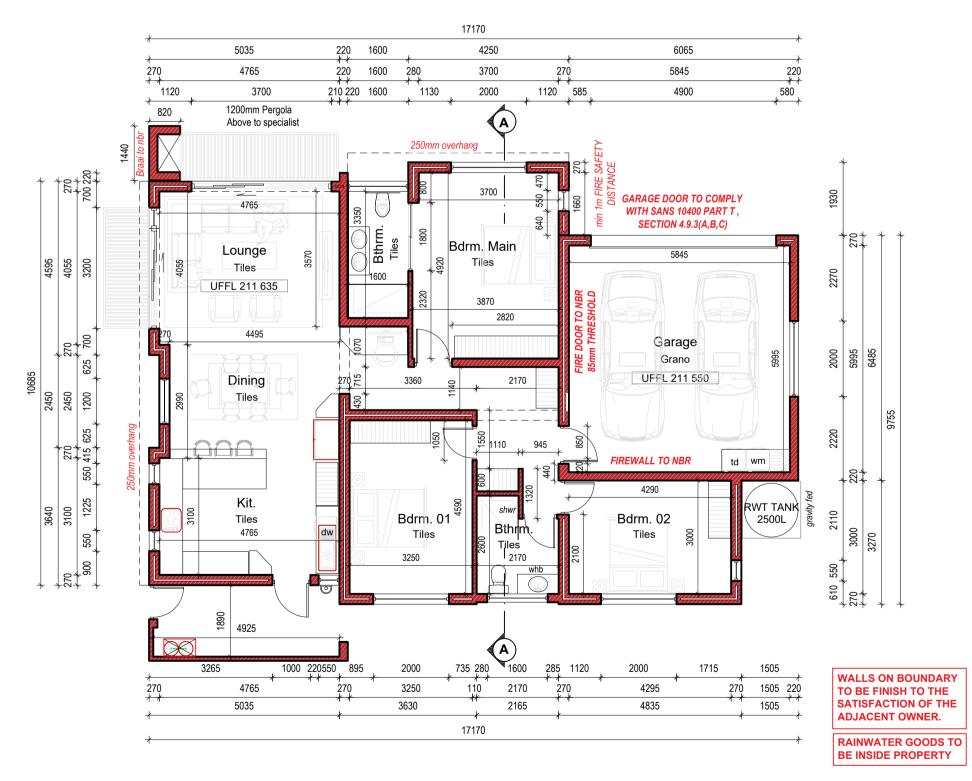

# **TYPICAL BOUNDARY WALL DETAIL**

MAX 2500mm

Brick colum with capping

plaster and painted

Bagged finish &

Paint in colour t

Kraaibosch HOA

**SEE PLAN FOR ACTUAL HEIGHT** 

ELEVATION

specifications

1910

Site boundary line



**COMPLY WITH SANS 10400 PART P.** 

**DRAINAGE INSTALLATIONS INDER** BUILDING WORK MUST BE

PROTECTED IN TERMS OF PART P OF SANS 10400 (4.22.2).

**DISCHARGE PIPES LOCATED** WITHIN A BUILDING TO BE ENCLOSED WITHIN A DUCT AND TO

**BE OF A SHAPE AND SIZE READILY ACCESSE FOR CLEANING IN TERMS** OF SANS 10400 PART P. 4.18.2

NOT STRUCTURE OR ANY PORTION THEREOF TO ENCROACH THE PROPERTY BOUNDARY.

RAINWATER GOODS TO BE INSIDE

RAINWATER NOT TO DISCHARGE ONTO NEIGHBOURING PROPERTY.

NO STRUCTURE OR ANY PORTION THEREOF TO ENCROACH THE PROPERTY BOUNDARY.

WALLS ON BOUNDARY TO BE FINISH TO THE SATISFACTION OF THE ADJACENT OWNER.

PERGOLA TO REMAIN OPEN AS PER

UILDING PLAN

P GAS: MAX 38KG ALLOWED ON PREMISES WITHOUT A FLAMMABLE UBSTANCE CERTIFICATE IN TERMS OF SECTION 37(6) OF THE **OMMUNITY FIRE SAFETY BY-LAW.** 

SANITARY FITTINGS DISCHARGING TO A GULLY TO DISCHARGE OVER THAT GULLY AS PER PART P OF

RAINAGE INSTALLATION TO

SANS 10400 (4.21).

RAINAGE INSTALLATIONS INDER BUILDING WORK MUST BE ROTECTED IN TERMS OF PART P OF SANS 10400 (4.22.2).

OMPLY WITH SANS 10400 PART P.

# **GENERAL NOTES**

**FOUNDATIONS** 

1.1 Concrete foundation to engineer design and specifications. See engineer's drawings for final layouts of foundations and structure beams and concrete slabs.

### **FLOORS**

2.1 25mm smooth floated screed on 85mm 1:3:6 concrete slab USB 250 micron damp proof membrane on 50mm sand blinding layer on

minimum 150mm well tamped hardcore. **2.2** Approved tile finish to fall.

#### **2.3** Approved floor finish to Kraaibosch park specifications. **2.4** Approved paving to Kraaibosch park specifications.

WALLS 3.1 Internal walls to be smooth plastered, skimmed and painted. All to

Paintsmiths specifications. Colour to be confirmed.

3.2 25 Degree down-tilted plastered external sill Waterproofing of sill to Paintsmiths specifications. **3.3** Stepped approved DPC to all cavity walls, leave a vertical joint open

after every 4th joint as weepholes. Door / Window to schedule.

**3.5** Plaster and paint to kraaibosch park guidelines. All to Paintsmiths specifications. **3.6** Approved clay face brick, size 222 x 106 x 73mm, bedded and jointed in

Class II mortar and pointed with flush vertical and flush horizontal joints, suitable for exposure zones 1-3.

#### 3.7 Approved stone cladding by specialist. CEILINGS

**4.1** Gyproc RhinoBoard® 9.5mm on 38 x 38mm brandering installed at maximum 400mm centres. Fix Gyproc RhinoBoard® using Gyproc Sharp-point Screws 25mm at maximum 150mm centres. All joints shall be staggered. Apply Gyproc RhinoTape to all joints and skim the ceiling using Gyproc RhinoLite® CreteStone.

- **4.2** Install Isover 135mm thick Aerolite non-combustible light weight Glasswool thermal ceiling insulation, nominal density, or similar approved. Cornice to finishing schedule. R-value: 3.38m² K/W Thermal conductivity: 0.04 W/m²/K.
- Insulation to comply with the requirements in SANS 10400. **4.3** Plaster and paint under side of concrete slab.
- 4.4 Everite Nutec 4mm thick plain ceiling boards, manufactured in accordance with SANS 9001:2000 carrying SANS 803:2005 mark, fixed


#### to 38 x 38mm battens at 450mm centres. ROOFS

- **5.1** 0.47mm pre approved Corrugated pre-coloured roof sheeting fixed to timber intermediate purlins spaced according to manufacturers specifications, on timber roof trusses to Engineers design and specifications. Roof colour to Kraaibosch Park guidelines. Confirm
- **5.2** Roof structure to Engineers design and specifications. **5.3** Watertite Guttering domestic aluminium Seamless ogee profile gutter, overall size 125 x 85 x 0,6mm thick coated internally and externally with ColourTech G4. Secured to 15x150mm fibre cement fascia with 20 x 2,5mm internal hanger brackets at 600mm centres using aluminium peeled rivets, with 75 x 50 x 0,6mm thick aluminium downpipe,colour to be confirmed, fixed to wall with straps at 1500mm centres using nail plugs, with downpipes riveted and silicone sealed to gutter outlets,
- including all necessary bends, elbows, shoes etc. Colour to be **5.4** RC beam /slab to Engineer design and specifications.
- **5.5** Cover end of roof with Nutec 80x150mm barge board.
- Flashing to roof manufacturer specifications. 5.7 Pre approved Concealed clip saflok or similar approved pre-coloured roof sheeting fixed to timber intermediate purlins spaced according to manufacturers specifications on timer roof trusses to Engineer design and specifications. Roof colour to kraaibosch park
- guidelines and finishing schedule. Confirm before ordering. **5.8** Water-permeable geofabric filter membrane to be laid over insulation with upstands at wall connections.
- 5.9 20mm Nominal size rounded gravel ballast to resist floating or wind lift
- of the insulation. **5.10** Steel / Timber pergola to specialist details and specifications.

#### **5.11** Galvanised mild steel Covered roof with Pre-approved roof sheeting on GMS frame closed off with nutec fibre cement ceiling board. To Specialist. Colour to be Confirmed.

**GENERAL** Wall light @ 2.4m high fittings to kraaibosch park specifications.

ALL TO COMPLY WITH RELEVANT SANS & NBR REQUIREMENTS

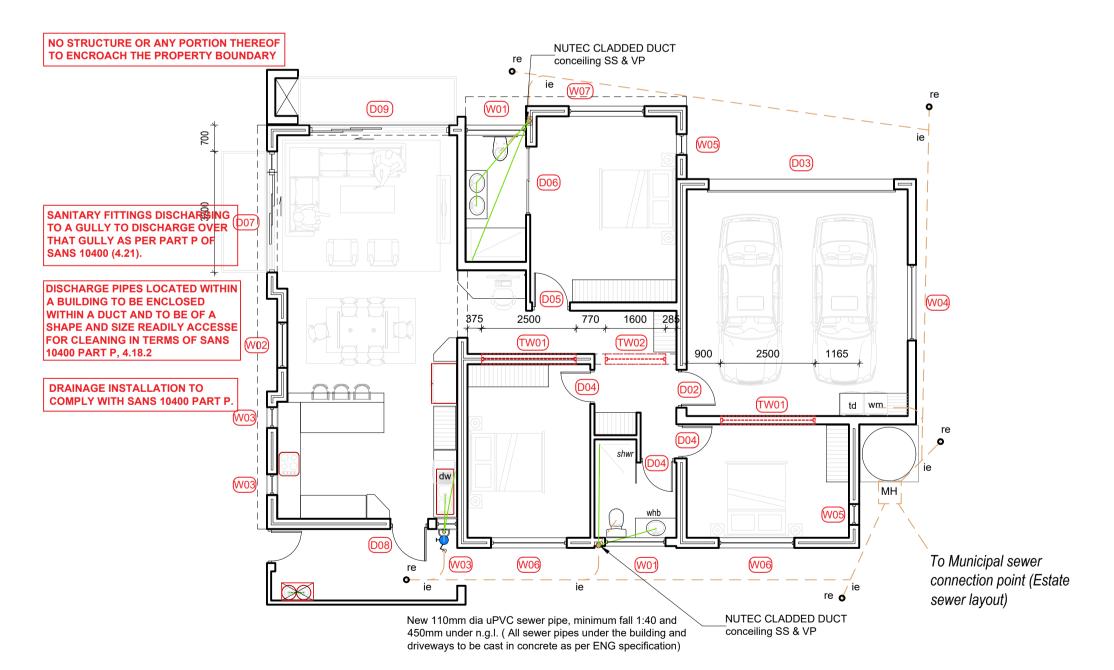

# **GROUND FLOOR PLAN DRAINAGE & REFERENCE PLAN SCALE 1:100**

## **GENERAL NOTES:**

from this drawings.

All drawings and measurements must be checked and verified before the ordering of materials or before any building takes place. Differences must be brought to the attention of the designer immediately. All work according to National Building Regulations and local authority rules. All building electrical and plumbing to comply with SANS 10400 regulations. The copyright on all drawings and designs are reserved. This drawing is to be read in conjunction with al relevant consultants drawings, details and specifications. Only the latest signed and approved drawings to be used. Never scale

**KRAAIBOSCH PARK** additions/alterations to this drawiing may be made without prior approval of the HOA DRP/EC **PLEASE NOTE:** 

**APPLICATION FOR ERF 29181** ONLY.

# KRAAIBOSCH PARK

NEW RESIDENCE FOR ERF 29181, in the Township of George, Kraaibosch Park



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NOTE: THIS DRAWING IS FOR STATUTORY APPROVAL PURPOSES ONLY. IT IS NOT A CONSTRUCTION DOCUMENT.	Covered Dwelling 29181
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**TECHNOLOGIST** 


REG. NO T0645 (SACAP)

178,49m


## **DRAWING:** SITE PLAN, FLOOR PLANS & **ELEVATIONS**

DATE: AS INDICATED 2023/07/12 DRAWING NUMBER:


ERF 29181 R1000

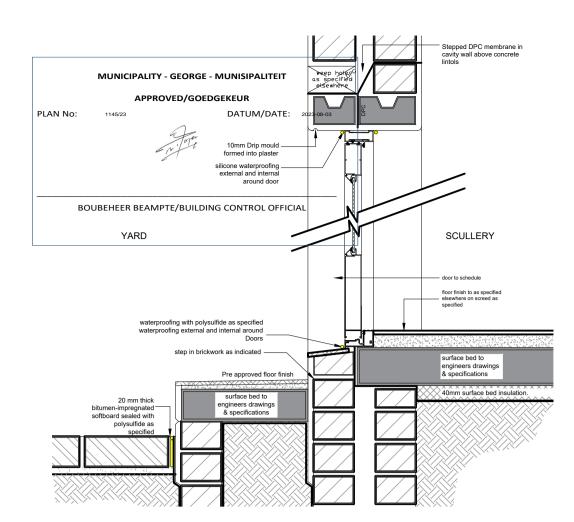


TYPICAL DOOR WITH STEP DETAIL SCALE 1:10

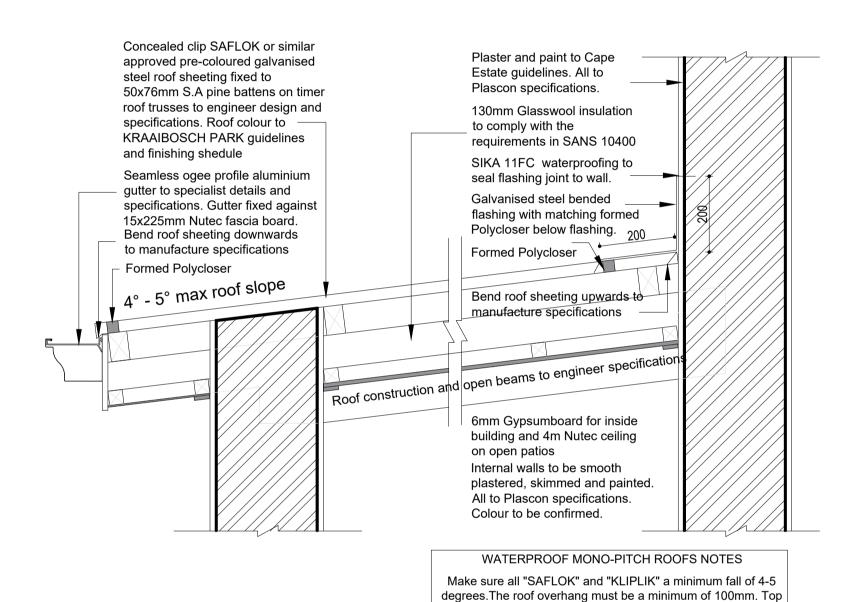

# TYPICAL SECTION OF MONO PITCH ROOF

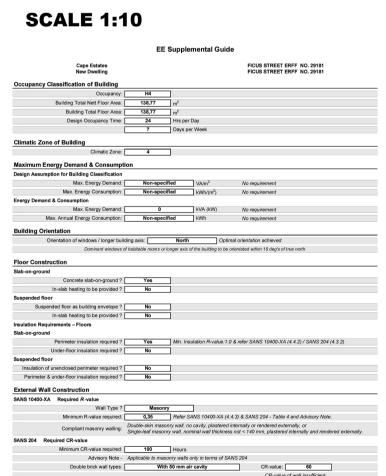

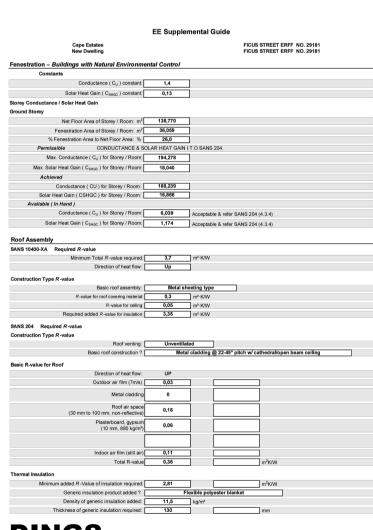

and bottom end must be bend to manufacture. "POLYCLOSER"

must be installed as indicated on detail. All flashing joints are cut, sealed with "Sika".

ENERGY EFFICIENCY IN BUILDINGS SANS 10400-XA & SANS 204 - REPORT

NOTES:

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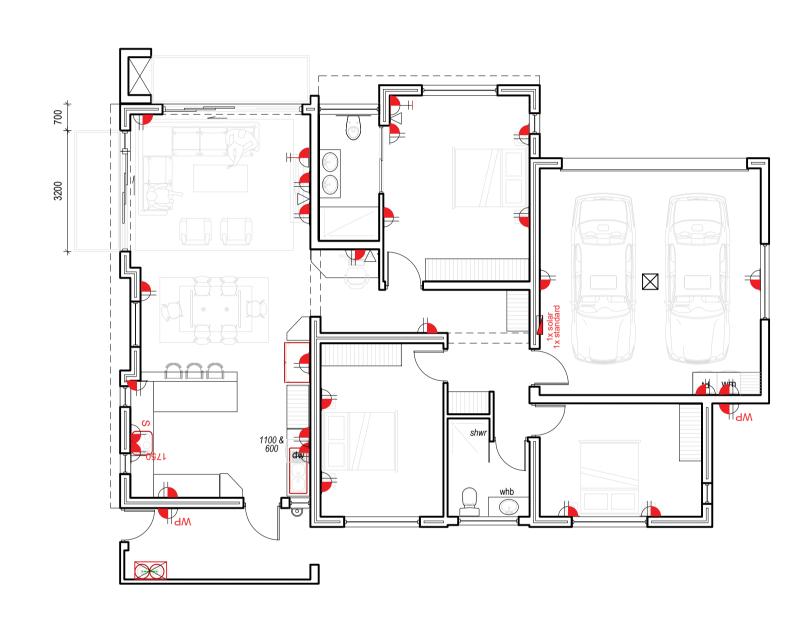


PLEASE NOTE:


APPLICATION FOR ERF 29181 ONLY.

# UIS OF BEAM 12° roof pitch 12° roof pitch 12° roof pitch 13° roof pitch 142 4.1 52 15.5 1


SECTION A-A SCALE 1:50



# GROUND FLOOR PLAN ELECTRICAL (PLUGS) SCALE 1:100

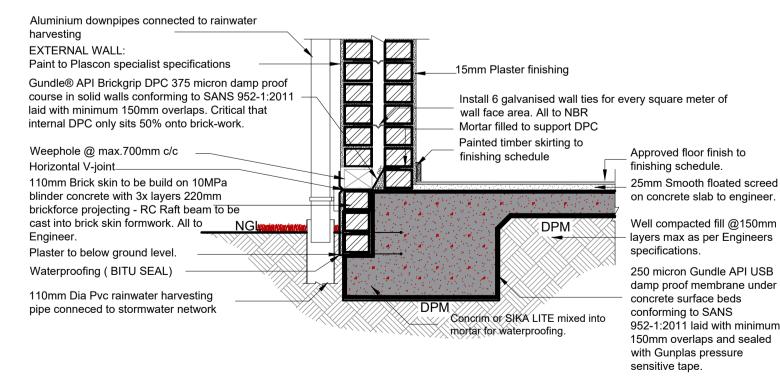

FOUNDATION & DOWNPIPE TO STORMWATER CONNECTION DETAIL

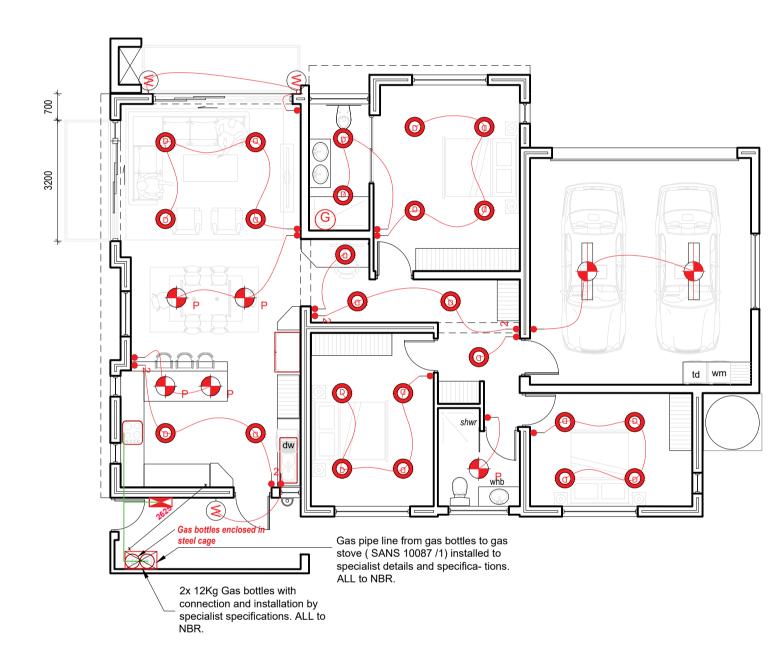


# GROUND FLOOR PLAN ELECTRICAL (LIGHTS & GAS) SCALE 1:100

	ELECTRICAL KEY		
	Main electrical distribution board	<b>+</b>	Ceiling mounted light / fan armature point.
	Single 15 AMP wall plug 300mm above F.F.L	P	Pendant light armature point. Exact height to be determined on site.
s	30 AMP single phase stove connection with isolator against wall 1100mm above F.F.L		1500x600mm 2Tube recessed fluorescent armature with prismatic diffuser.
_	Double 15 AMP wall plug 300mm above F.F.L (1100mm above F.F.L in kitchen)	₩)	Watertight light armature point 2100mm high vertically mounted against wall.
WP	Waterproof double 15 AMP wall plug 300mm above F.F.L (1100mm above F.F.L in kitchen)	<b>(</b>	Light armature point 2100mm high vertically mounted against wall.
<b>▲</b> SP	Shaver plug point	W	Watertight light armature point
$\triangleleft$	Telephone & DATA point mounted 300mm above F.F.L	<b>(1)</b>	Watertight down lighters.
<del> </del>	TV point.	0	Down lighters.
$\boxtimes$	Point for remote controlled electrically operated garage door.	HE	Bathroom heater + extractor
•	Single light switch wall mounted 1200mm above F.F.L	G	Position 150L / 200L KWIKOT hot water cylinde
<b>—</b> 2	Two way light switch wall mounted 1200mm above F.F.L		Gas water heater

# KRAAIBOSCH PARK

NEW RESIDENCE FOR ERF 29181, in the Township of George, Kraaibosch Park



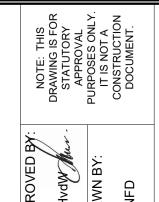



DRAWING:
SERVICES & DETAILS

SCALE: DATE:
AS INDICATED 2023/07/12

DRAWING NUMBER:

ERF 29181 R1-2000

